PROPOSED TWO STOREY DWELLING WITH BASEMENT & POOL AT 50 CHASELING ST, GREENACRE




	DRAWING LIST
Sheet Number	Sheet Name
A00	COVER SHEET
A01.01	DEMOLITION PLAN
A01.02	SITE PLAN & ROOF PLAN, SITE ANALYSIS PLAN
A01.03	WASTE MANAGEMENT PLAN AND SEDIMENT & EROSION CONTROL PLAN
A01.04	LANDSCAPING PLAN
A01.05	SITE CALCULATIONS
A02	PROPOSED BASEMENT FLOOR PLAN
A03	PROPOSED GROUND FLOOR PLAN
A04	PROPOSED FIRST FLOOR PLAN
A05.01	ELEVATIONS - PART 1
A05.02	ELEVATIONS - PART 2
A06	SECTION 1, DRIVEWAY SECTION & POOL SECTION
A07	3D_BASEMENT FLOOR
A08	3D_GROUND FLOOR
A09	3D_FIRST FLOOR
A10	3D_MODEL
A11	3D_MODEL
A12	WINDOWS & DOORS SCHEDULE
A13	SCHEDULE OF MATERIALS& FINISHES
A14	STREETSCAPE VIEW & FRONT FENCE ELEVATION
A15.01	SHADOW DIAGRAM - 21ST JUN
A15.02	3 HOURS OF SUNLIGHT TO LIVING - 21ST JUN
A15.03	3 HOURS OF SUNLIGHT TO 50% POS - 20TH MAR
A16	BASIX REQUIREMENTS
A17.01	NOTIFICATION PLANS - PART 1
A17.02	NOTIFICATION PLANS - PART 2


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REV	DATE	DESCRIPTION	ВҮ	Design.




SS: I, LEVEL 1, I CHAPEL RD, BANKSTOWN, 200 5556 M: 0422 606 228 ham@nemcodesign.com.au	PROPOSED TWO STOREY DWELLING WITH BASEMENT & POOL	JOB NUMBER: 22808	DWG NUMBER:	ORIGINAL SIZE: A3
	50 CHASELING ST, GREENACRE LOT 75, DP 35156	DESIGNED BY: A.N.	DATE: 03.02.2023	
	COVER SHEET	drawn by: A.N.	SCALE: AS SHOWN	


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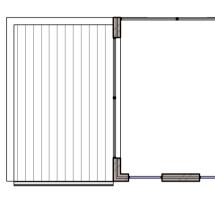


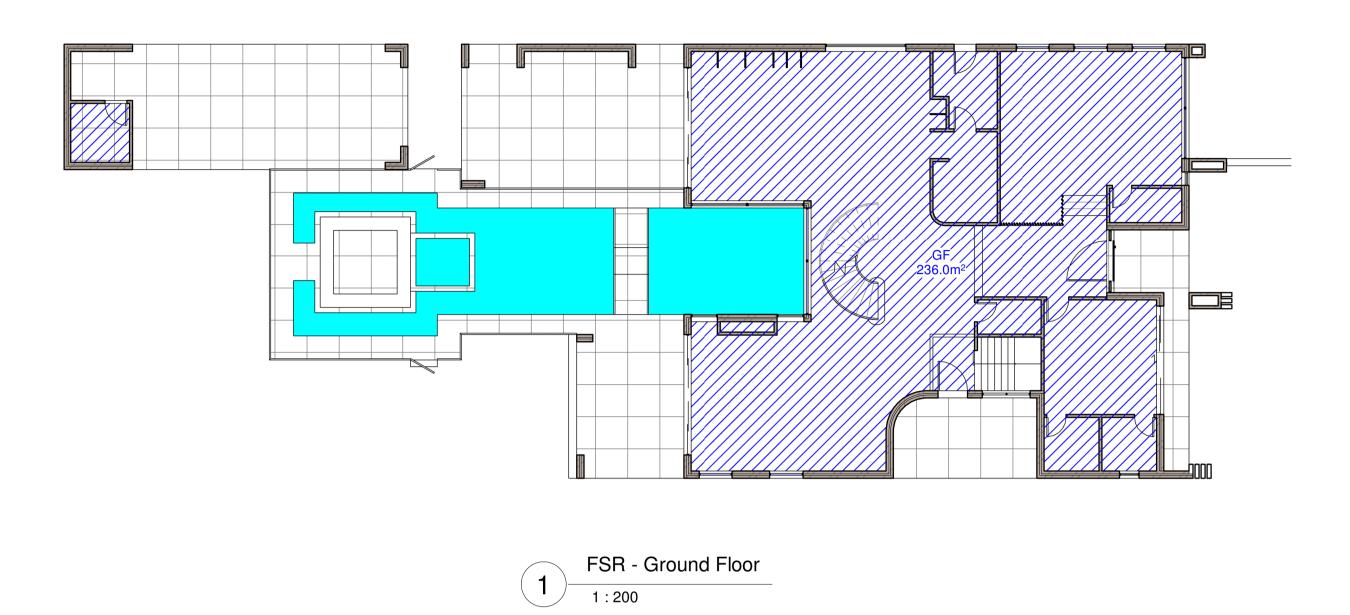

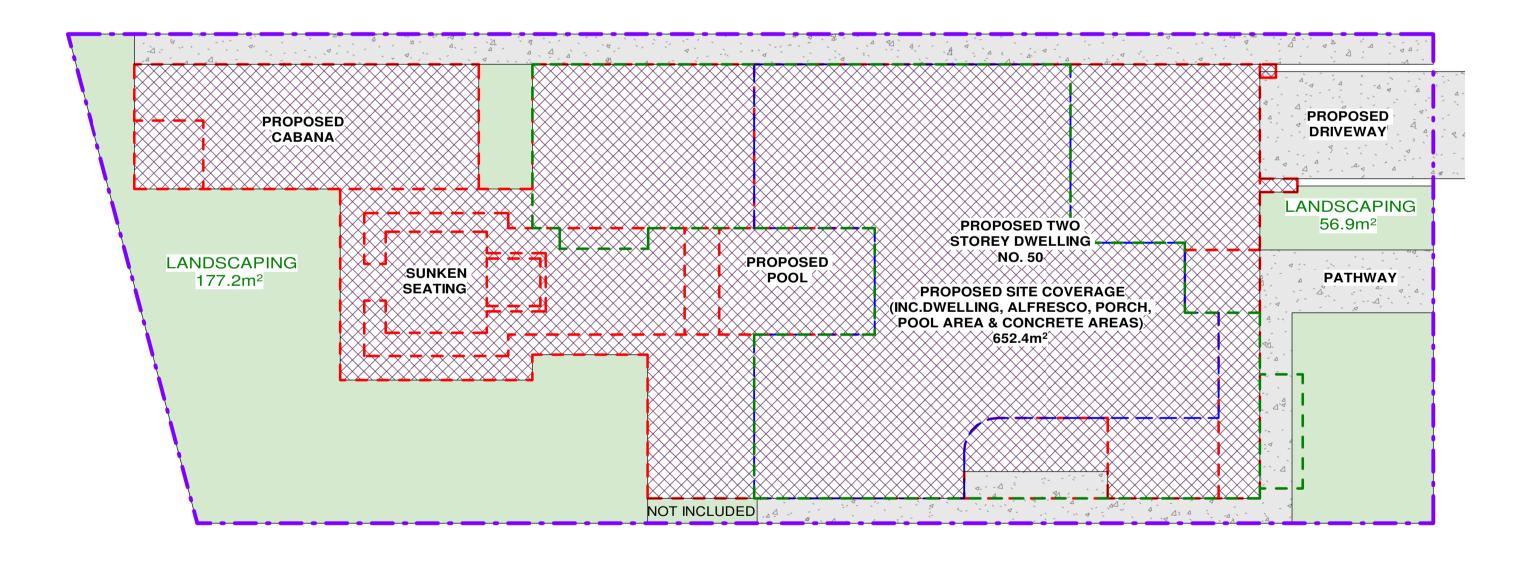



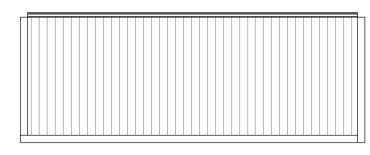

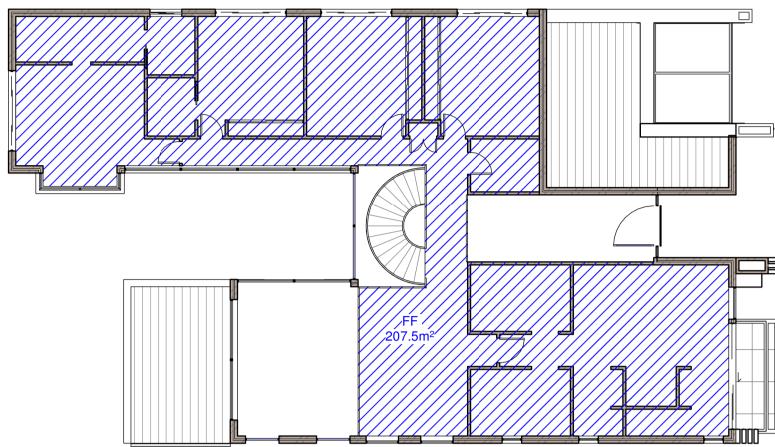


2 FSR - First Floor

SITE CALCULATIONS			
FLOOR AREA CALCULATIONS			
SITE AREA:	890.2m ²		
AREA OF THE PROPOSED GROUND FLOOR: AREA OF THE PROPOSED FIRST FLOOR:	236.0m ² 207.5m ²		
MAX. TOTAL FLOOR AREA	445.1m ²		
50% OF SITE AREA = 0.50 x 890.2m ² PROPOSED TOTAL FLOOR AREA:	443.5m ²	<	445.1m ²
SITE COVERAGE CALCULATIONS			
PROPOSED SITE COVERAGE: (INC. DWELLING, PORCH, ALFRESCO, POOL AREA & CONCRETE)	652.4m ²	(73	.3%)
LANDSCAPING CALCULATIONS			
MIN. LANDSC. FORWARD OF BUILDING LINE: 45% OF THE AREA OF THE LOT FORWARD OF THE BUILDING LINE= 0.45 x 120.9m ²	54.4m ²		
PROPOSED LANDSCAPING AT FRONT:	56.9m ²	>	54.4m ²
PROPOSED LANDSCAPING AT REAR:	177.2m ²		
PROPOSED TOTAL LANDSCAPING AREA:	234.1m ²	(26	.3%)


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REV	DATE	DESCRIPTION	ВҮ	Design.	STRUCTURAL ENGINEERING & ARCHITECTURAL DESIGN

iS: LEVEL 1, CHAPEL RD, BANKSTOWN,)0 5556 M: 0422 606 228 am@nemcodesign.com.au	PROPOSED TWO STOREY DWELLING WITH BASEMENT & POOL	JOB NUMBER: 22808	DWG NUMBER: A01.05	ORIGINAL SIZE: A3
	50 CHASELING ST, GREENACRE LOT 75, DP 35156 SITE CALCULATIONS	DESIGNED BY: A.N.	DATE: 03.02.2023	\bigcirc
		DRAWN BY: A.N.	SCALE: AS SHOWN	

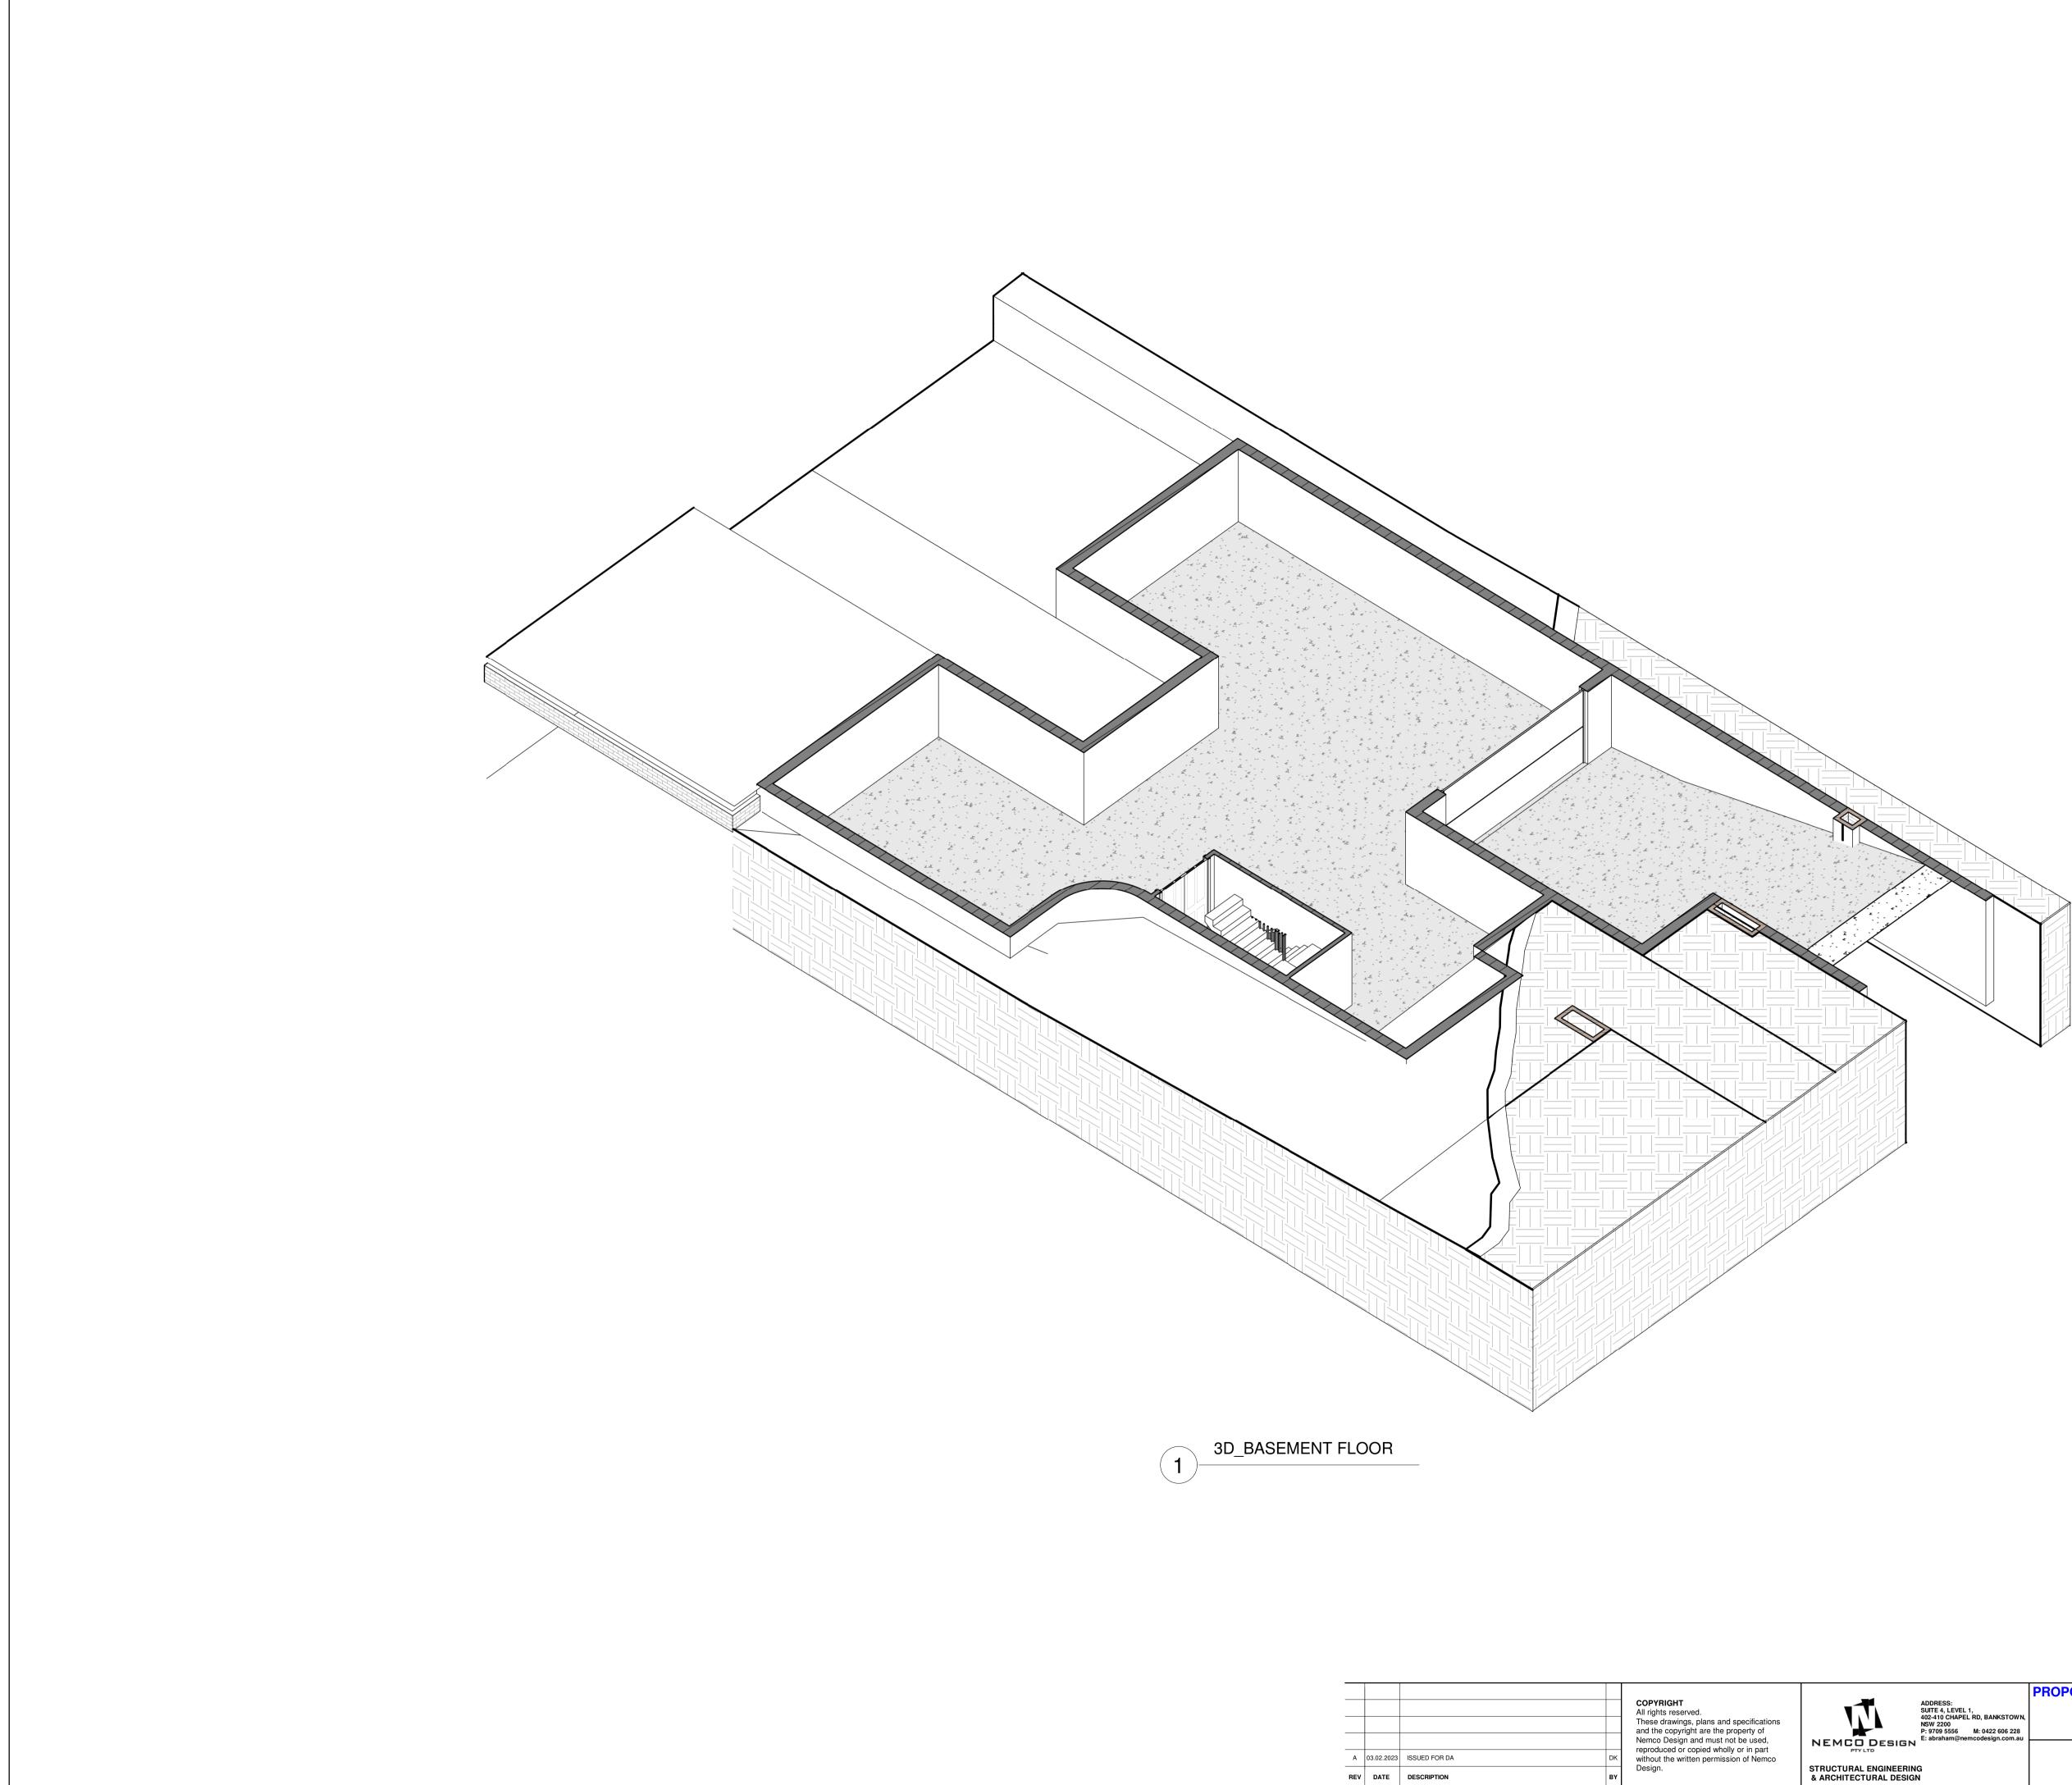


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REV	DATE	DESCRIPTION	вү	Design.	STRUCTURAL ENGINEERING & ARCHITECTURAL DESIGN

SS: LEVEL 1, CHAPEL RD, BANKSTOWN, 00 5556 M: 0422 606 228 Jam@nemcodesign.com.au	PROPOSED TWO STOREY DWELLING WITH BASEMENT & POOL	JOB NUMBER: 22808	DWG NUMBER:	ORIGINAL SIZE: A3
	50 CHASELING ST, GREENACRE LOT 75, DP 35156	DESIGNED BY: A.N.	DATE: 03.02.2023	\bigcirc
	3D_BASEMENT FLOOR	DRAWN BY: A.N.	SCALE: AS SHOWN	KD

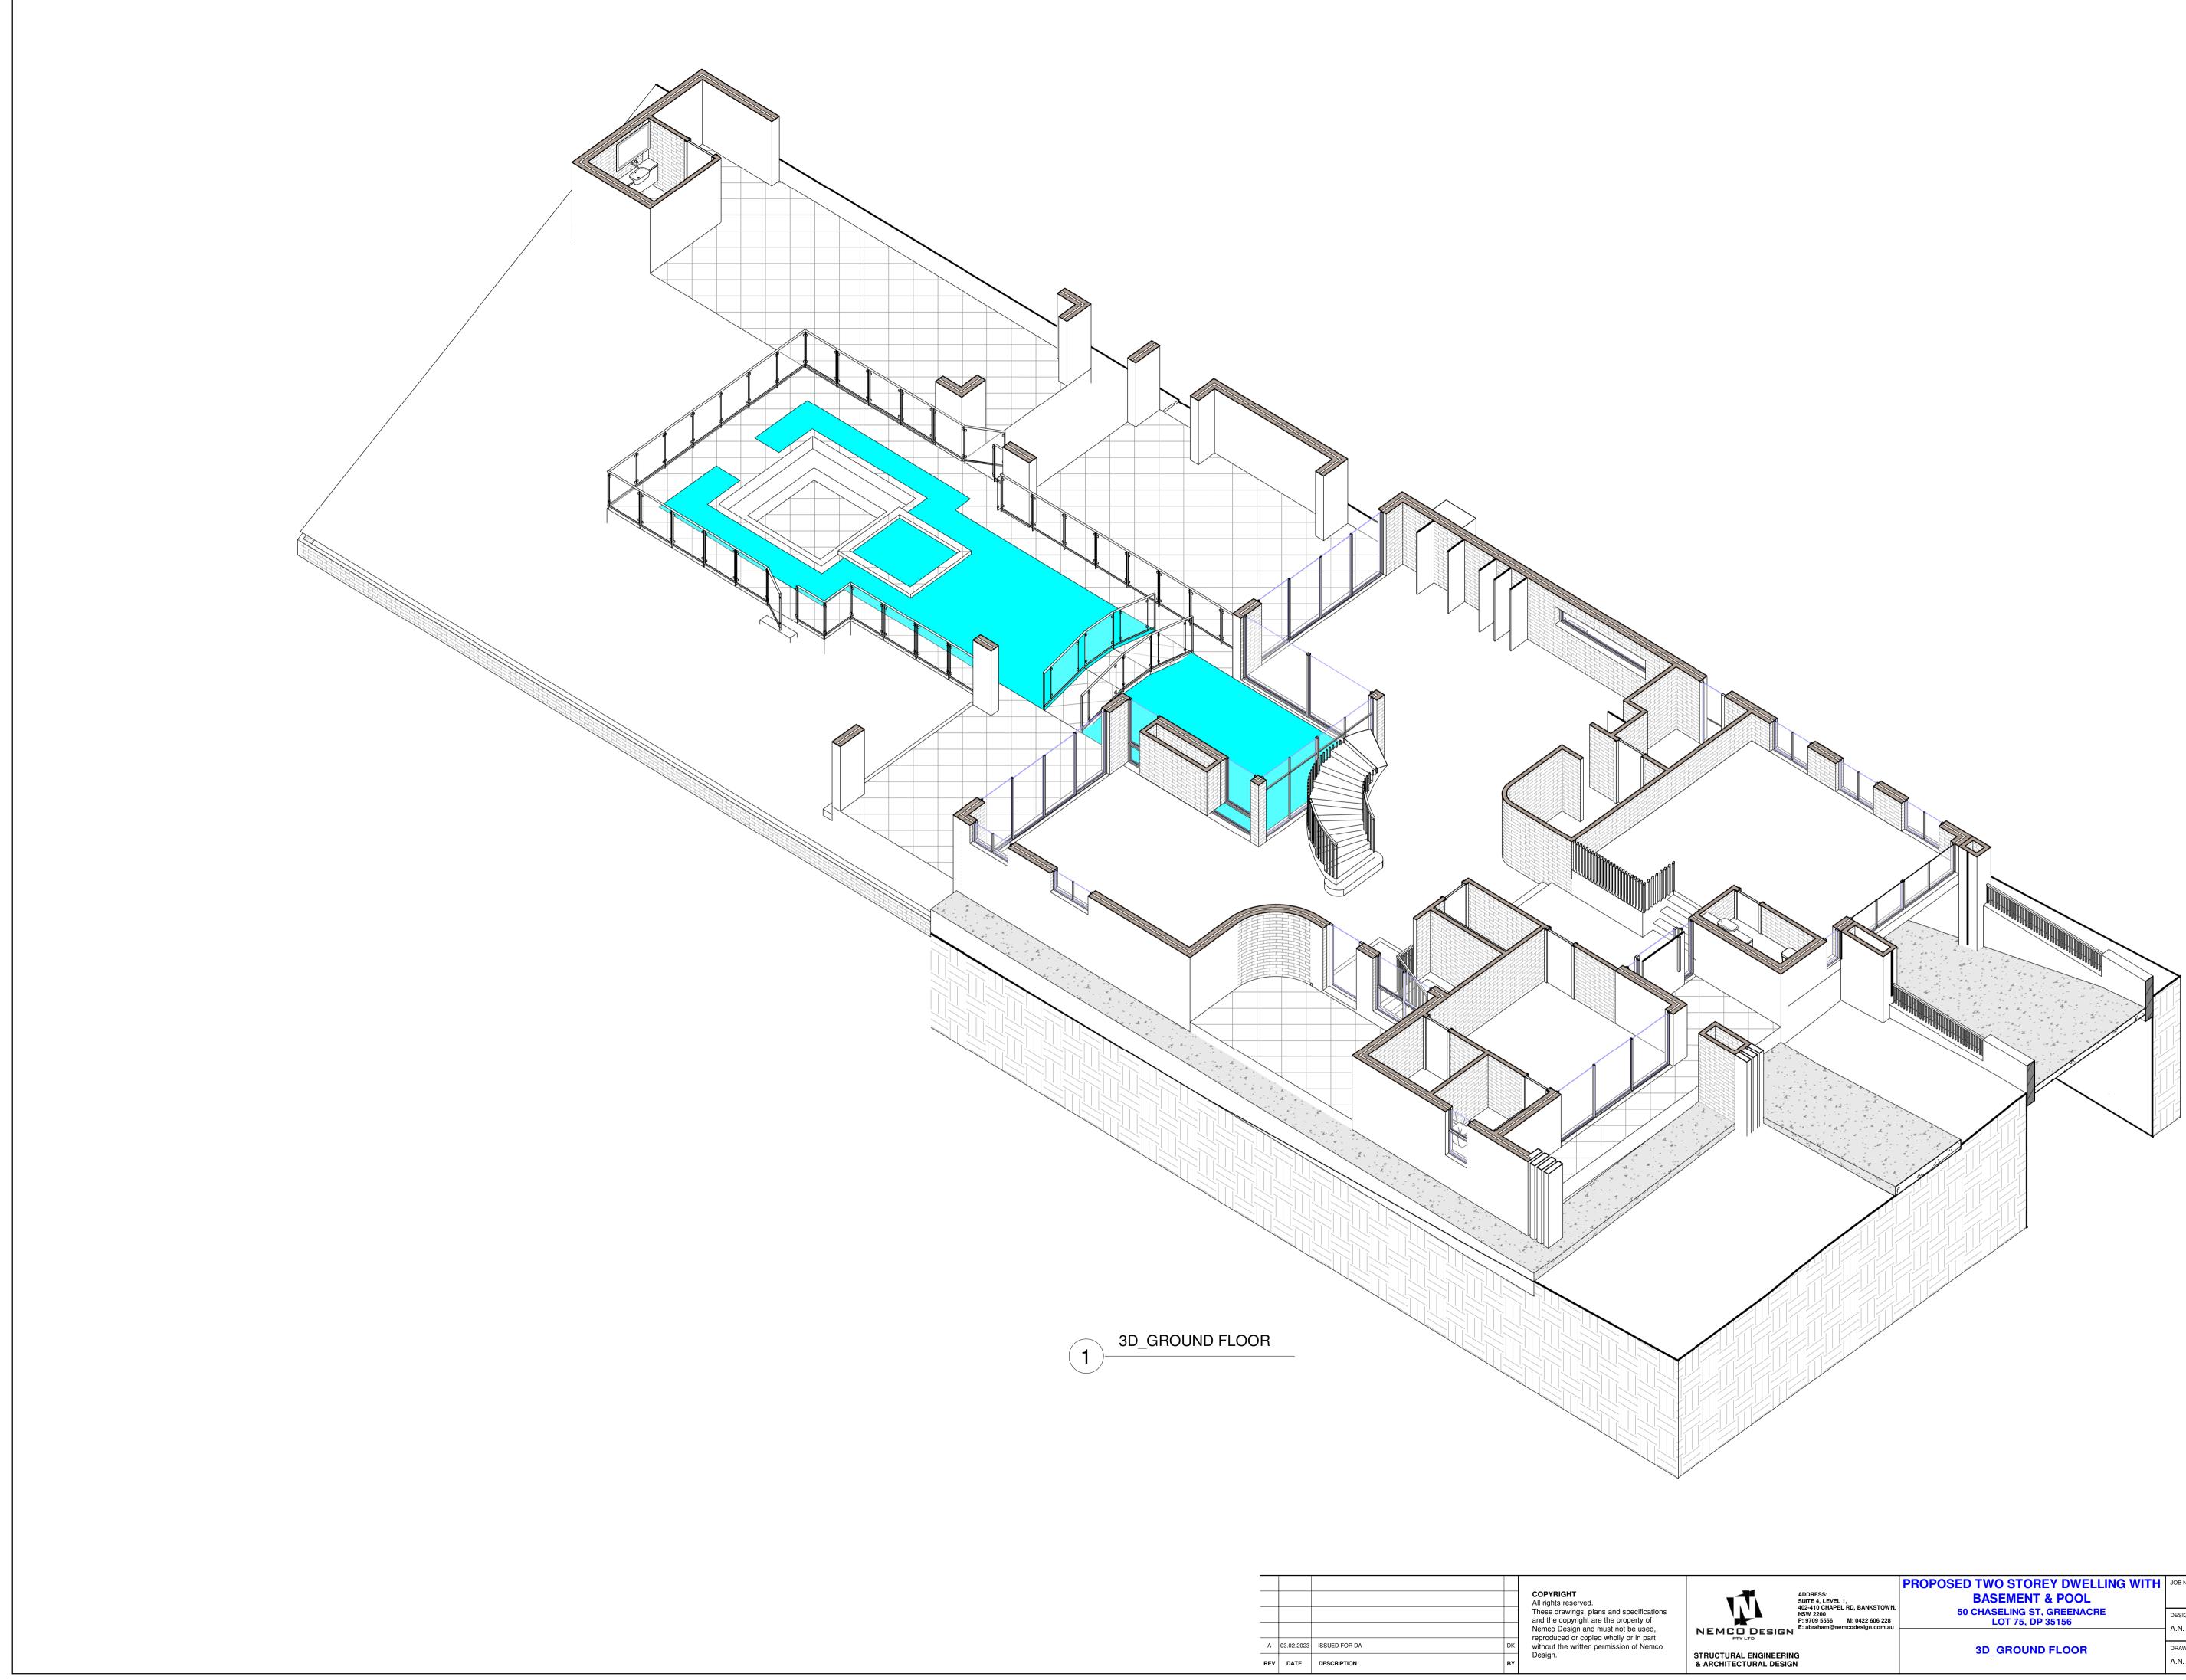


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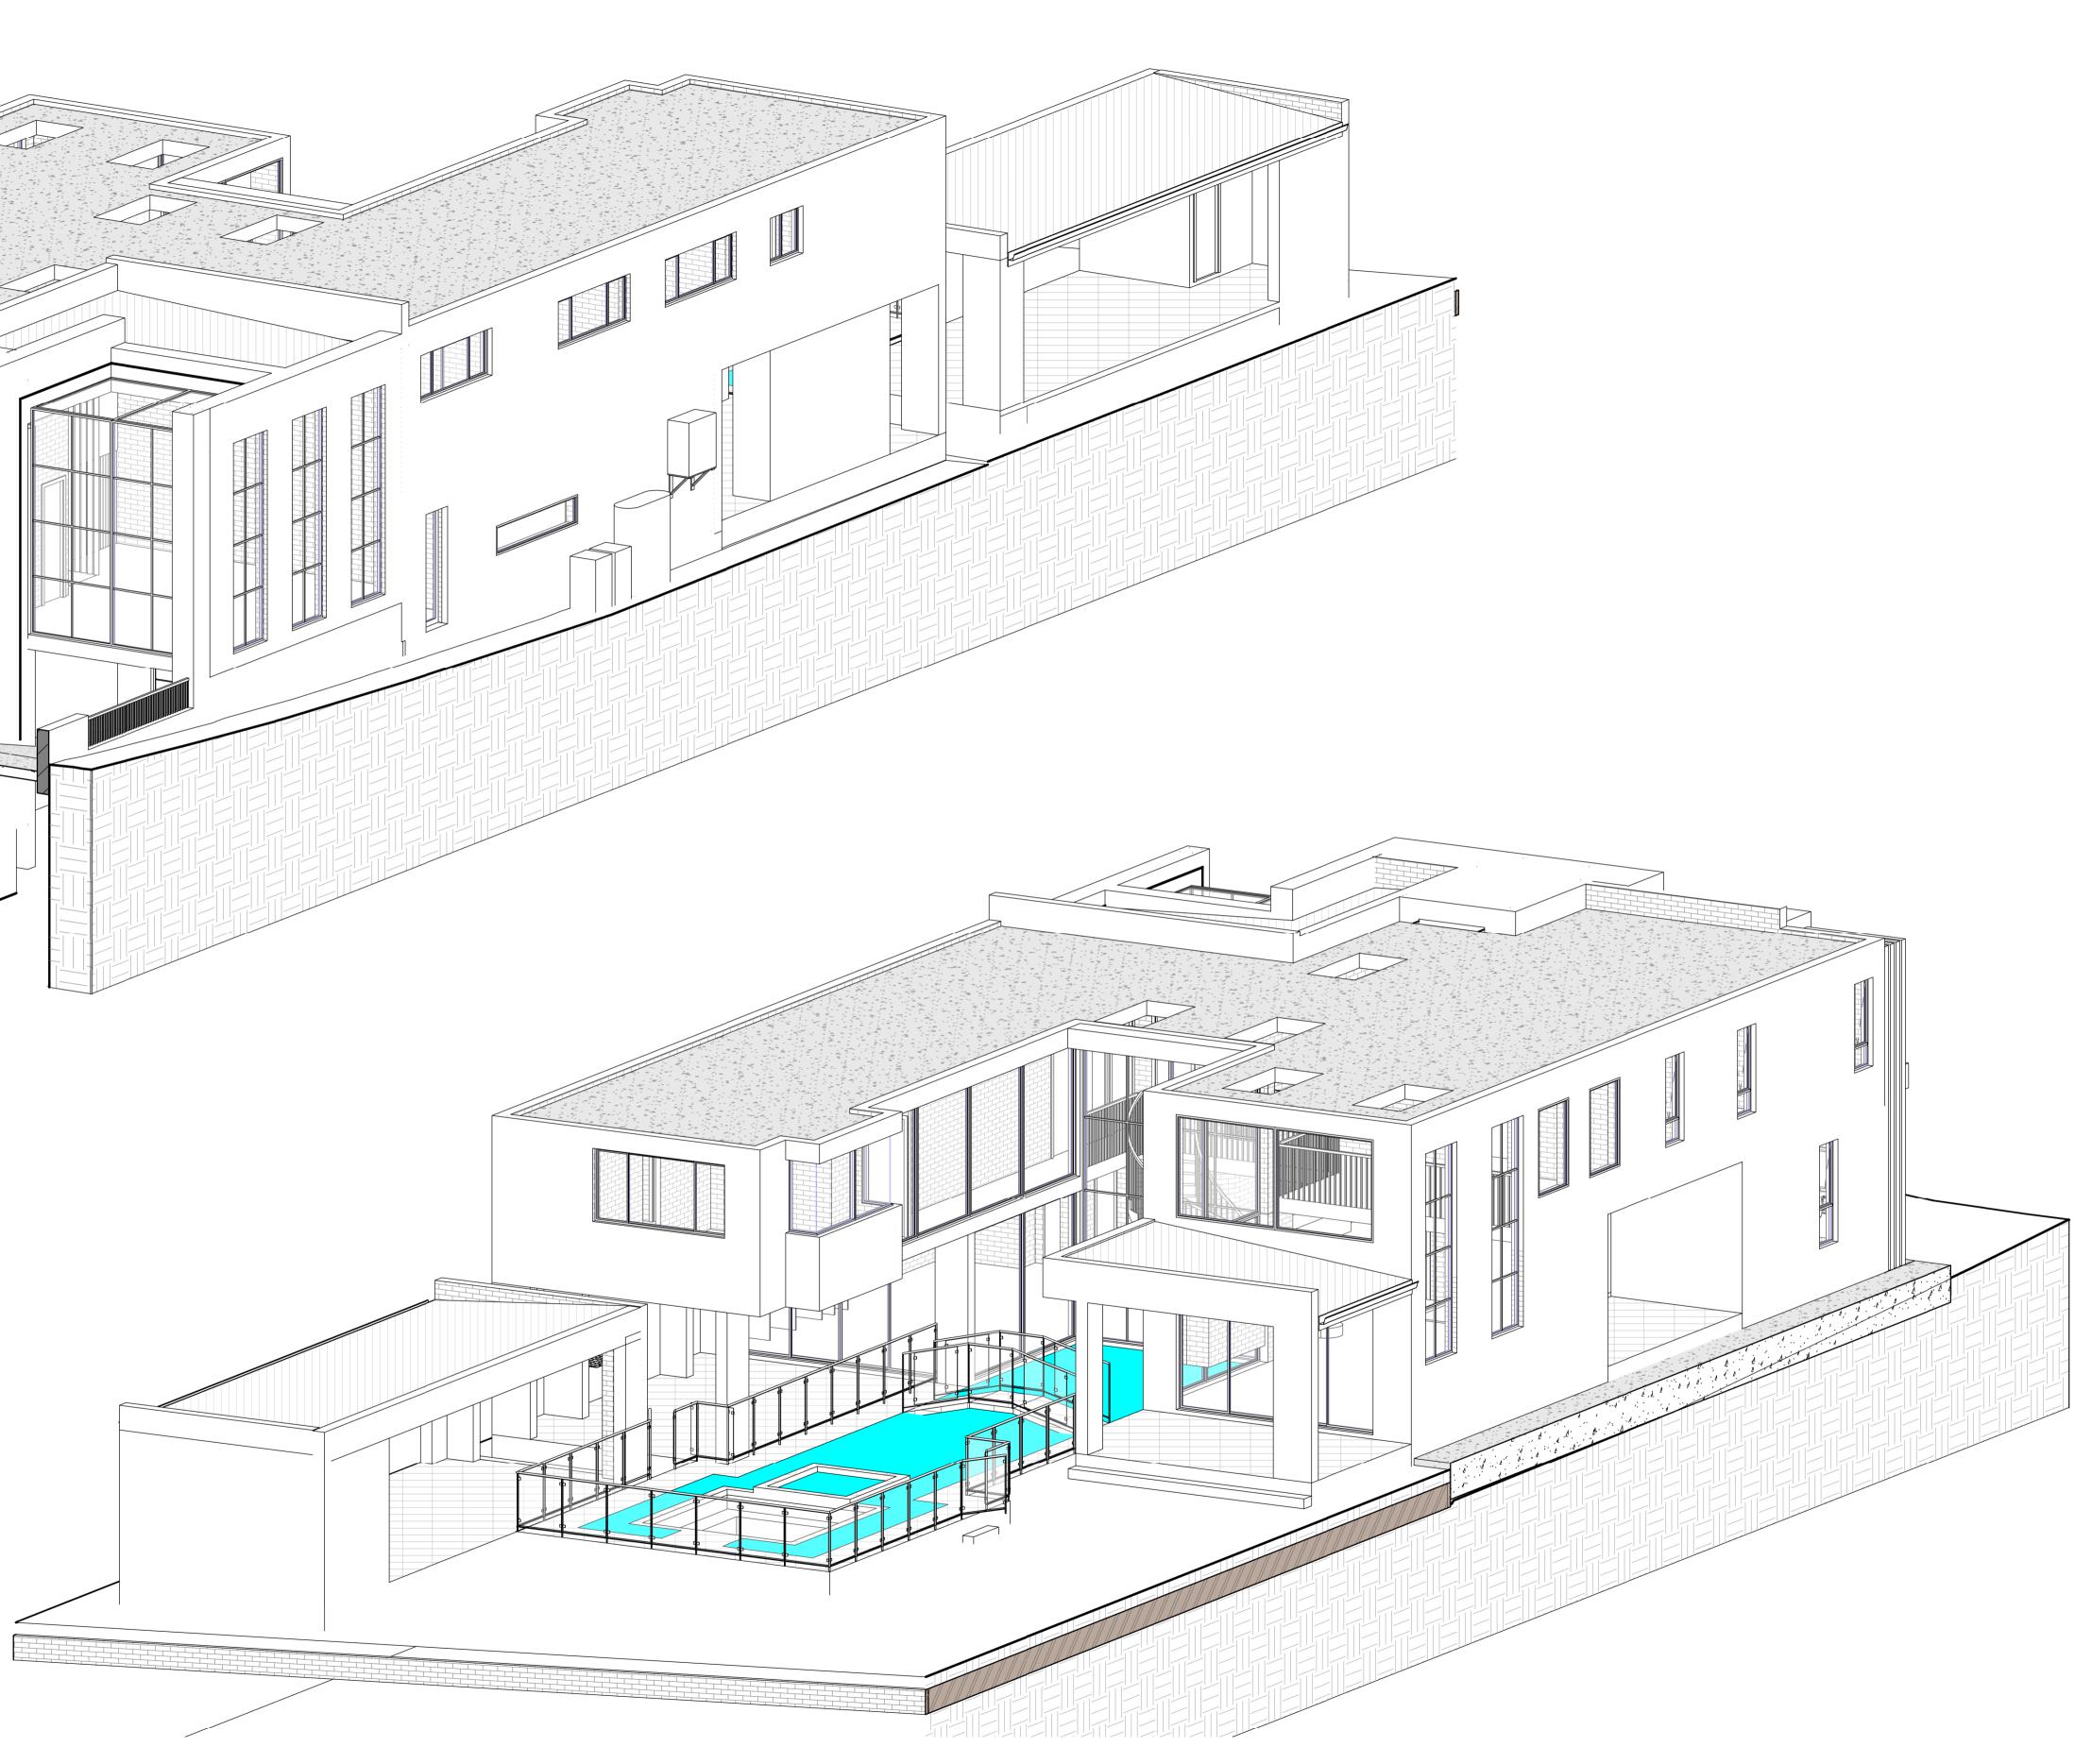
S: LEVEL 1, CHAPEL RD, BANKSTOWN, 10 5556 M: 0422 606 228 am@nemcodesign.com.au	PROPOSED TWO STOREY DWELLING WITH BASEMENT & POOL	JOB NUMBER: 22808	DWG NUMBER: A08	ORIGINAL SIZE: A3	
	3D_GROUND FLOOR	DESIGNED BY: A.N.	DATE: 03.02.2023	\bigcirc	
		DRAWN BY: A.N.	SCALE: AS SHOWN		

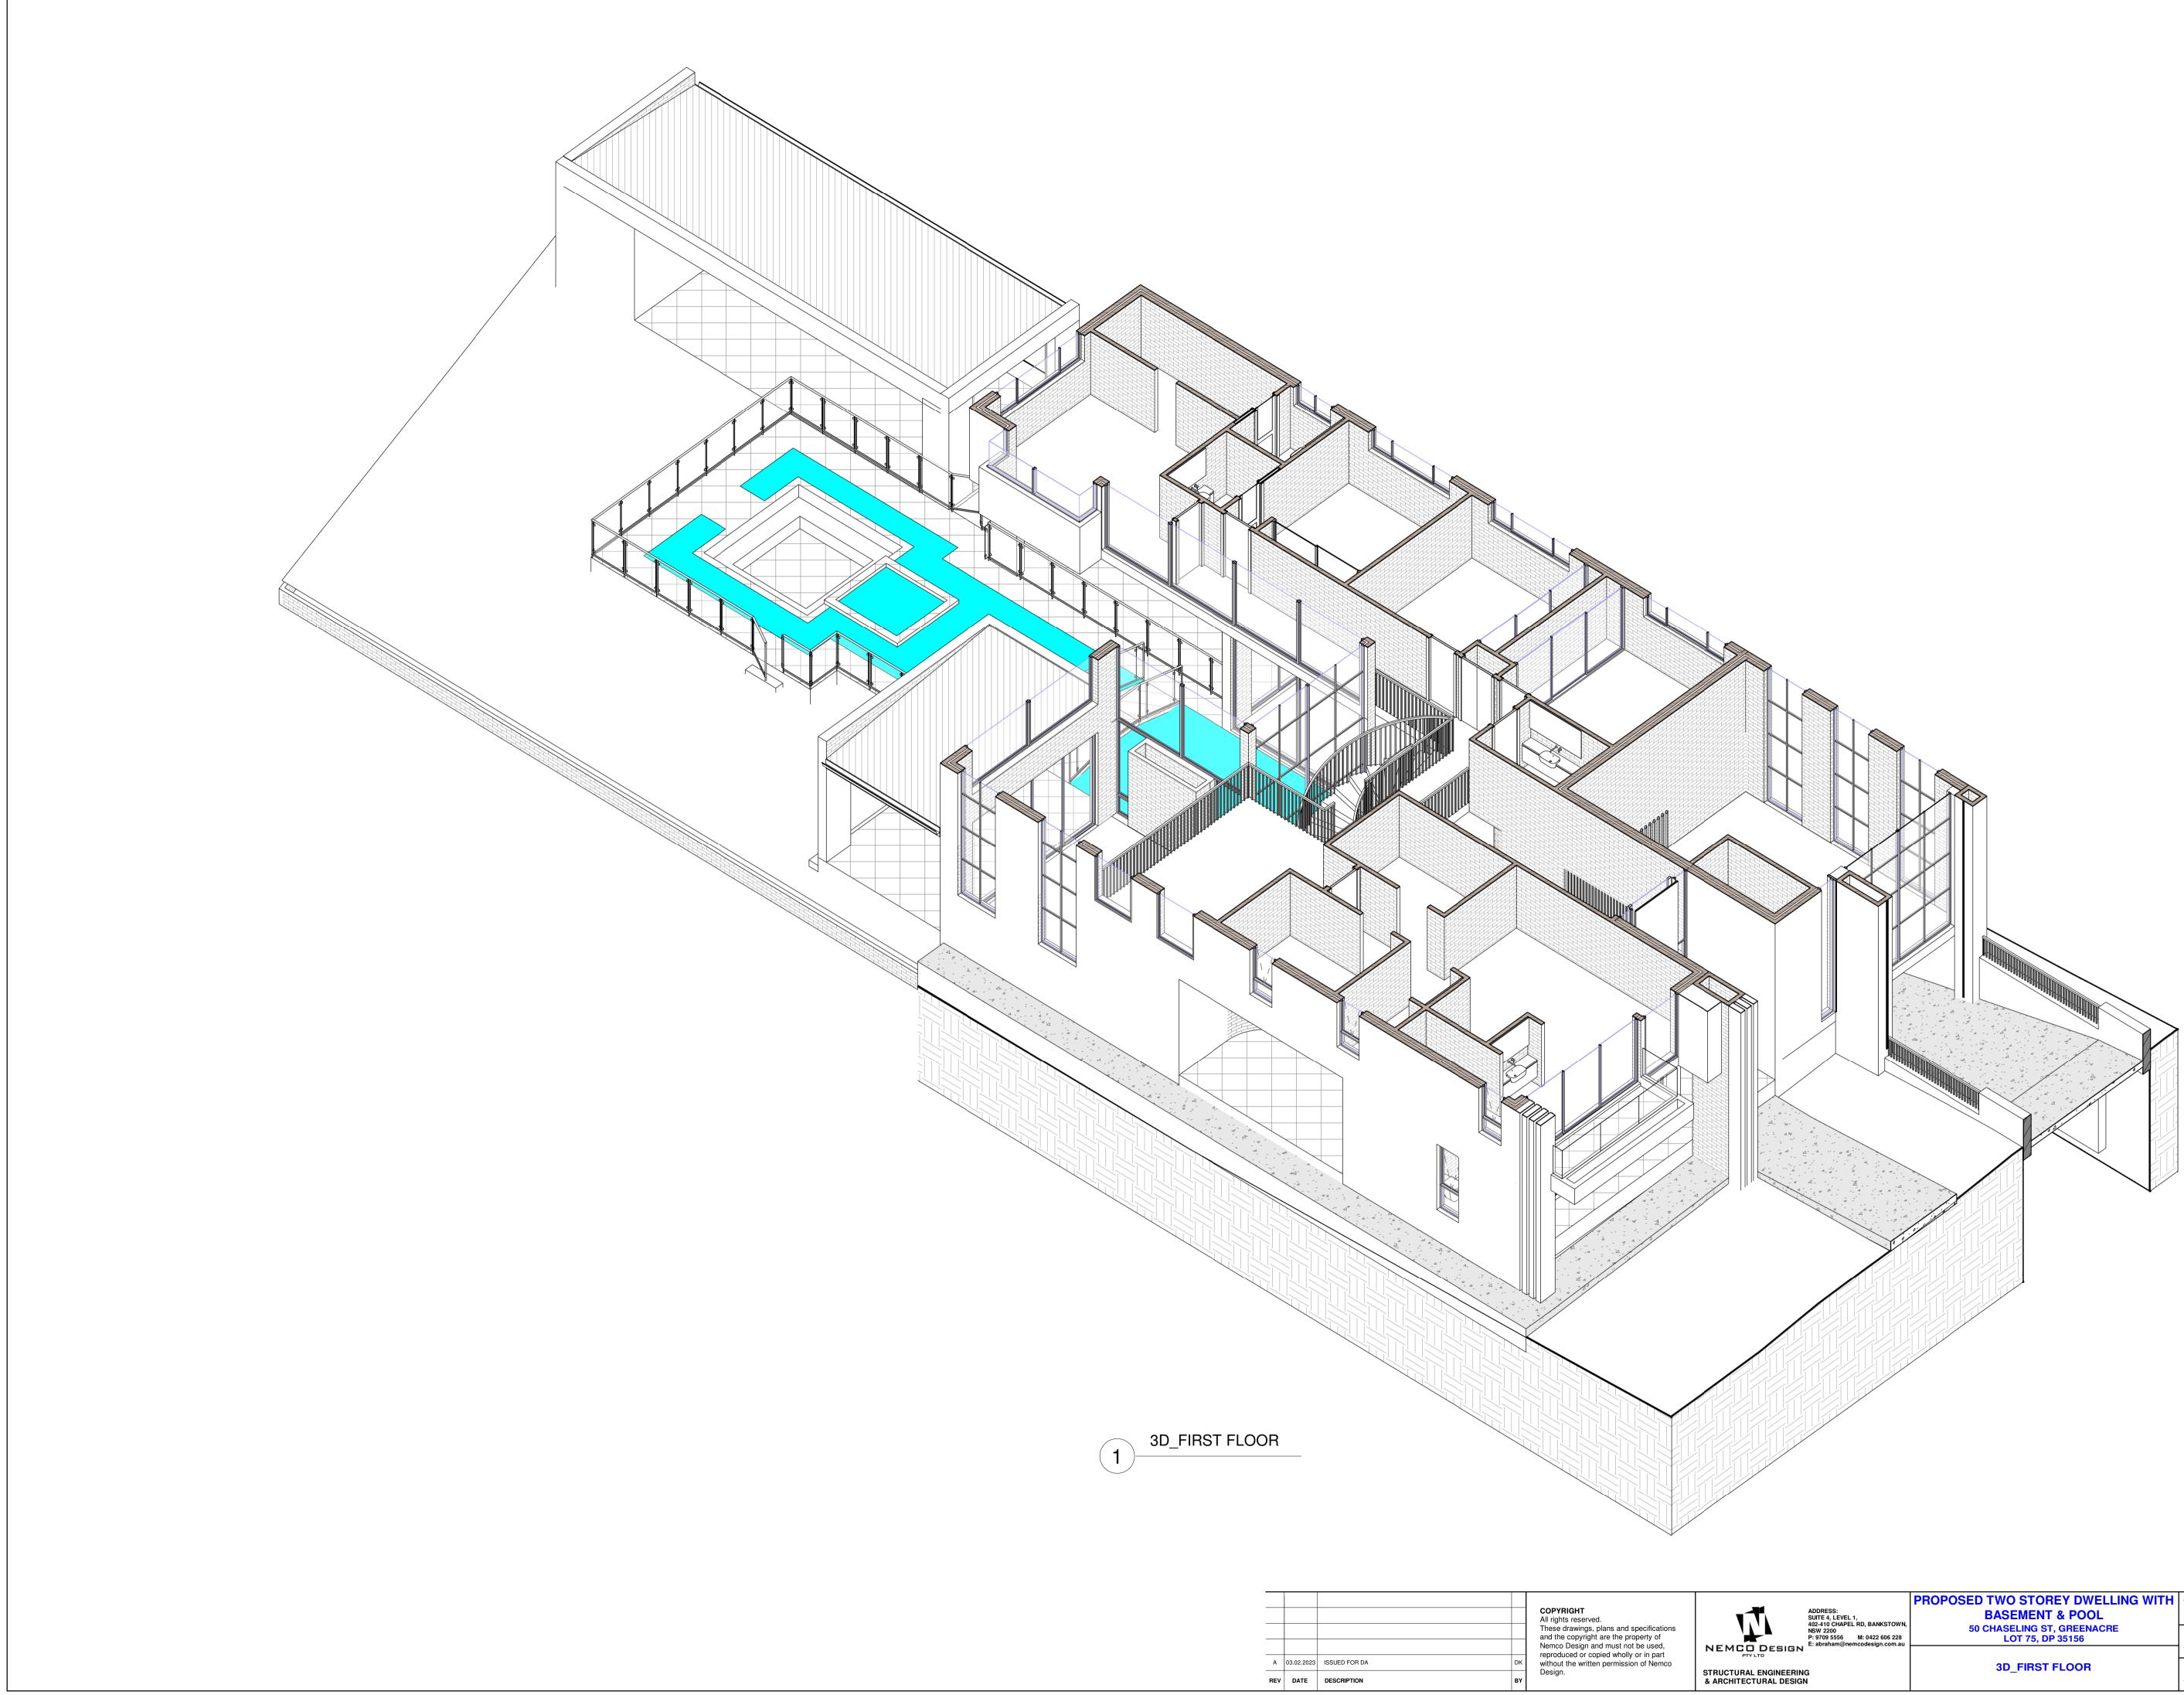

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DESCRIPTION	BY	Design.

S: LEVEL 1, CHAPEL RD, BANKSTOWN, 0 5556 M: 0422 606 228 am@nemcodesign.com.au	PROPOSED TWO STOREY DWELLING WITH BASEMENT & POOL	JOB NUMBER: 22808	DWG NUMBER: A09	ORIGINAL SIZE: A3	
	3D_FIRST FLOOR	DESIGNED BY: A.N.	DATE: 03.02.2023		
		DRAWN BY: A.N.	SCALE: AS SHOWN		



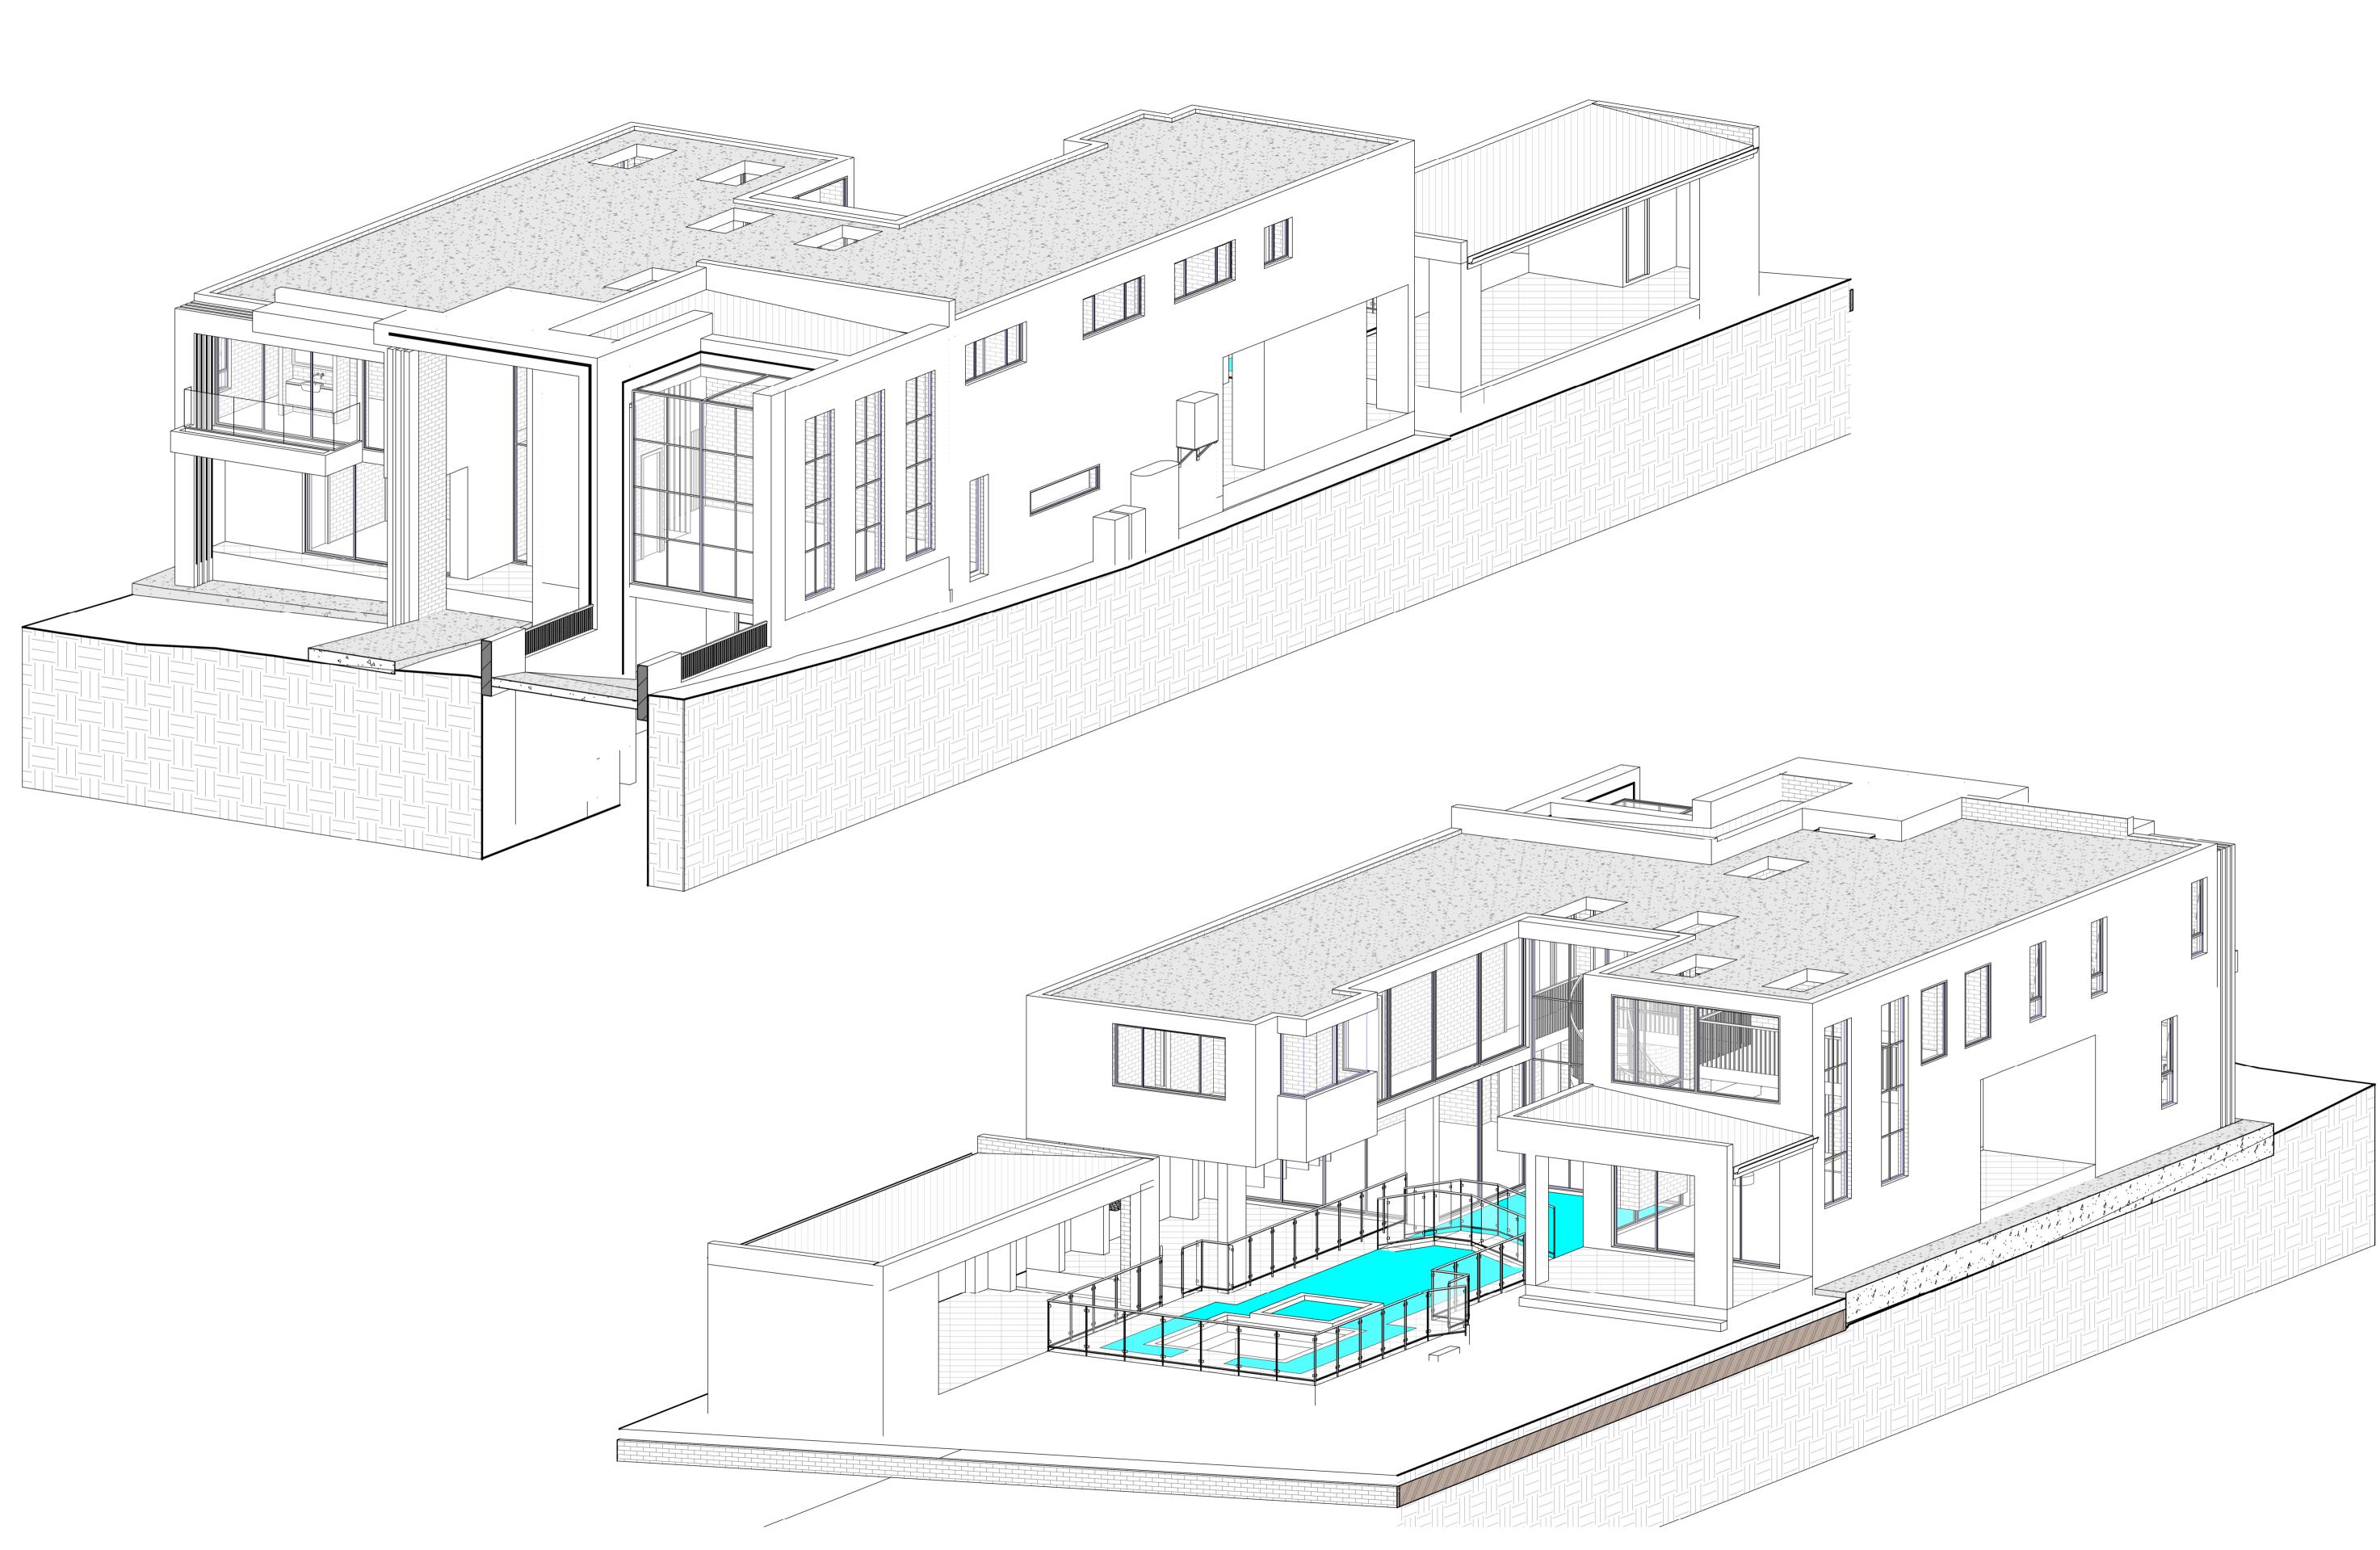

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REV	DATE	DESCRIPTION	ВҮ	Design.	STRUCTURAL ENGINEERING & ARCHITECTURAL DESIGN

	PROPOSED TWO STOREY DWELLING WITH	JOB NUMBER:	DWG NUMBER:	ORIGINAL SIZE:
S: LEVEL 1,	BASEMENT & POOL	22808	A10	A3
CHAPEL RD, BANKSTOWN, 00 5556 M: 0422 606 228 am@nemcodesign.com.au	50 CHASELING ST, GREENACRE LOT 75, DP 35156	DESIGNED BY:	DATE: 03.02.2023	$\left(\right)$
am@nemcooesign.com.au	3D_MODEL	DRAWN BY: A.N.	SCALE: AS SHOWN	





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S: LEVEL 1,	PROPOSED TWO STOREY DWELLING WITH BASEMENT & POOL	JOB NUMBER: 22808	DWG NUMBER: A11	ORIGINAL SIZE: A3
CHAPEL RD, BANKSTOWN, 0 5556 M: 0422 606 228 am@nemcodesign.com.au	50 CHASELING ST, GREENACRE LOT 75, DP 35156	DESIGNED BY: A.N.	DATE: 03.02.2023	\bigcirc
	3D_MODEL	DRAWN BY: A.N.	SCALE: AS SHOWN	

vv				
Mark	Height	Width	Area	Level
W1	6000	435	2.61 m ²	HGF1
W2	6000	435	2.61 m ²	HGF1
W3	4600	500	2.30 m ²	HGF2
W4	4600	1885	8.67 m ²	HGF2
W5	4600	1885	8.67 m ²	HGF2
W6	4300	1250	5.38 m ²	HGF2
W7	4300	1250	5.38 m ²	HGF2
W8	4300	1250	5.38 m ²	HGF2
W9	600	3000	1.80 m ²	GF
W10	3000	2115	6.35 m ²	GF
W11	3000	2115	6.35 m ²	GF
W12	6000	2000	12.00 m ²	GF
W13	6000	2000	12.00 m ²	GF
W10	2400	1000	2.40 m ²	GF
W15	2400	1000	2.40 m ²	GF
W16	600	2115	1.27 m ²	GF
W17	600	2115	1.27 m ²	GF
W18	4300	1250	5.38 m ²	FF
W19	4300	1250	5.38 m ²	FF
W20	2100	1810	3.80 m ²	GF
W21	2100	730	1.53 m ²	HGF1
W22	2400	1200	2.88 m ²	FF
W23	970	2650	2.57 m ²	FF
W24	970	2650	2.57 m ²	FF
W25	970	2650	2.57 m ²	FF
W26	970	1210	1.17 m ²	FF
W27	1500	640	0.96 m ²	FF
W28	1500	1520	2.28 m ²	FF
W29	1500	1520	2.28 m ²	FF
W30	1500	640	0.96 m ²	FF
W31	2700	2115	5.71 m ²	FF
W32	2700	2115	5.71 m ²	FF
W33	2700	2115	5.71 m ²	FF
W34	2700	2115	5.71 m ²	FF
W35	3000	2115	6.35 m ²	FF
W36	3000	2115	6.35 m ²	FF
W37	2100	2250	4.73 m ²	FF
W38	2100	2250	4.73 m ²	FF
W39	1800	1210	2.18 m ²	FF
W40	1800	1210	2.18 m ²	FF
W41	1800	730	1.31 m ²	FF
W42	1800	730	1.31 m ²	FF
W43	1800	730	1.31 m ²	FF
W44	1500	3000	4.50 m ²	FF
Grand to			178.92 m ²	

WINDOWS SCHEDULE - DWELLING


GLASS DOORS SCHEDULE - DWELLING

Mark	Height	Width	Area	Level
SD1	2700	4050	10.94 m ²	HGF1
SD2	3000	4495	13.49 m ²	GF
SD3	3000	4495	13.49 m ²	GF
SD4	2400	3960	9.50 m ²	FF
Grand to	otal: 4		47.41 m ²	


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SS: , LEVEL 1, , CHAPEL RD. BANKSTOWN.	PROPOSED TWO STOREY DWELLING WITH BASEMENT & POOL	JOB NUMBER: 22808	DWG NUMBER: A12	ORIGINAL SIZE: A3
00 5556 M: 0422 606 228 nam@nemcodesign.com.au	50 CHASELING ST, GREENACRE LOT 75, DP 35156	DESIGNED BY: A.N.	DATE: 03.02.2023	\bigcirc
	WINDOWS & DOORS SCHEDULE	DRAWN BY: A.N.	SCALE: AS SHOWN	






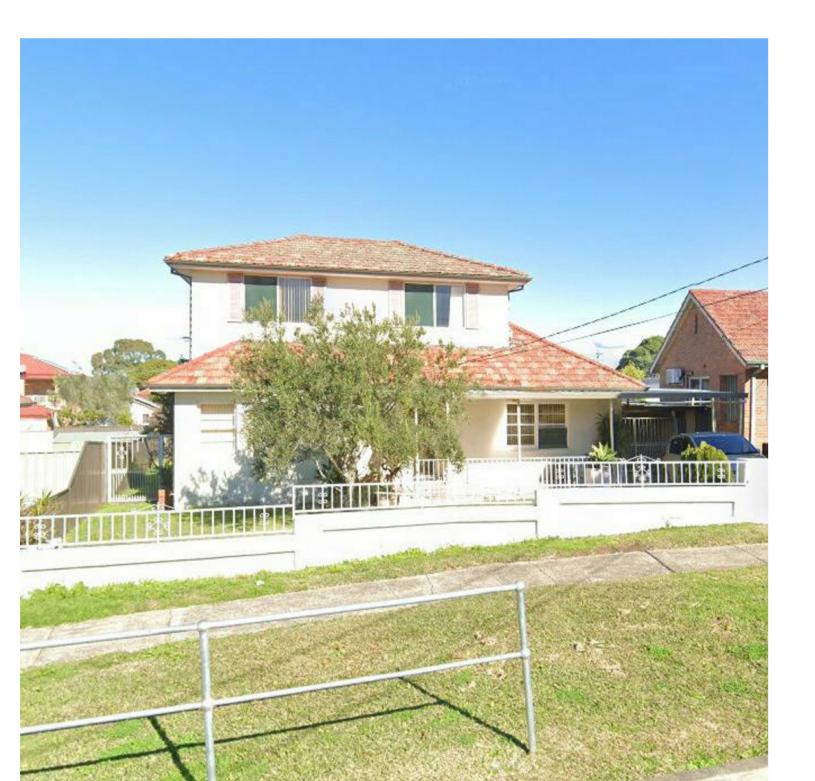

PROPOSED FRONT FENCE MAX 1.2M HIGH

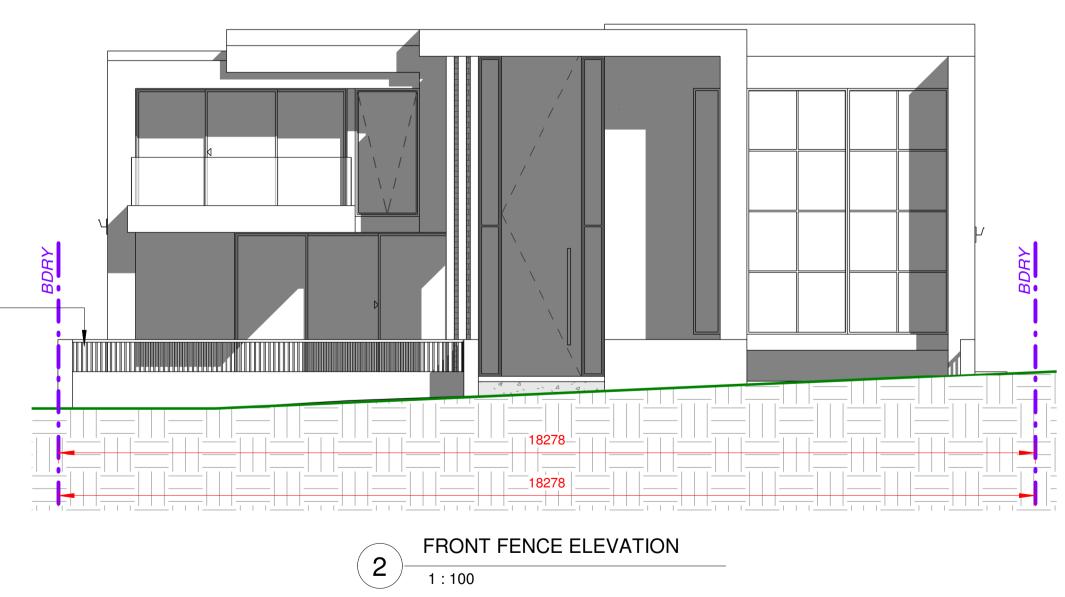No. 48

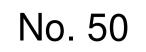



CHASELING STREET

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			These drawings, plans and specifications and the copyright are the property of Nemco Design and must not be used,	NSW 2200 P: 9709 5556 M: 0422 606 228	50 CHASELING ST, GREENACRE LOT 75, DP 35156	DESIGNED BY:	DATE: 03.02.2023	
A	03.02.2023 ISSUED FOR DA	DK	reproduced or copied wholly or in part without the written permission of Nemco		STREETSCAPE VIEW & FRONT FENCE		SCALE:	
REV	DATE DESCRIPTION	вү	Design.	STRUCTURAL ENGINEERING & ARCHITECTURAL DESIGN	ELEVATION	A.N.	AS SHOWN	



No. 52



Single Dwelling

Certificate number: 1367246S

This certificate confirms that the proposed development will meet the NSW government's requirements for sustainability, if it is built in accordance with the commitments set out below. Terms used in this certificate, or in the commitments, have the meaning given by the document entitled "BASIX Definitions" dated 10/09/2020 published by the Department. This document is available at www.basix.nsw.gov.au

Secretary Date of issue: Tuesday, 24 January 2023 To be valid, this certificate must be lodged within 3 months of the date of issue.



Project name	50 Chaseling St, G	reenacre			
Street address	50 Chaseling Stree	t Greenacre 2190			
Local Government Area	Canterbury-Bankste	own Council			
Plan type and plan number	deposited 35156				
Lot no.	75				
Section no.	-	-			
Project type	separate dwelling h	ouse			
No. of bedrooms	6				
Project score					
Water	40	Target 40			
Thermal Comfort	V Pass	Target Pass			
Energy	✓ 50	Target 50			

Project name	50 Chaseling St, Greenacre	Assessor number	n/a		
Street address	50 Chaseling Street Greenacre 2190	Certificate number	n/a		
Local Government Area	Canterbury-Bankstown Council	Climate zone	n/a		
Plan type and plan number	Deposited Plan 35156	Area adjusted cooling load (MJ/m ² .year)	n/a		
Lot no.	75	Area adjusted heating load (MJ/m ² .year)	n/a		
Section no.	-	Ceiling fan in at least one bedroom	n/a		
Project type		Ceiling fan in at least one living room or other conditioned area	n/a		
Project type separate dwelling house		Project score			
No. of bedrooms	6	Floject score			
Site details		Water	40	Target 40	
Site area (m²)	890	Thermal Comfort	V Pass	Target Pass	
Roof area (m²)	421		• • • • • • • • • • • • • • • • • • • •	raiget abo	
Conditioned floor area (m2)	299.9	Energy	50	Target 50	
Unconditioned floor area (m2)	18.48				
Total area of garden and lawn (m2)	100				

BASIX Planning, Industry & Environment www.basix.nsw.gov.au Version: 3.0 / DARWINIA_3_20_0 Certificate No.: 1367246S Tuesday, 24 January 2023

Certificate Prepared by Name / Company Name: Nemco Design ABN (if applicable): 46166160505

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BASIX	Planning, Industry & Environment	www.basix.nsw.gov.au	Version: 3.0 / DARWINIA_3_20_0	Certificate No.: 1367246S	Tuesday, 24 January 2023

eneral features		DA plans	plans & specs	check	
he dwelling must not have more than 2 storeys.					
le dwelling must not have more than 2 storeys.		 ✓ 	 Image: A set of the set of the	~	
he conditioned floor area of the dwelling must not exceed	<u> </u>	_	_		
he dwelling must not contain open mezzanine area excee			Ú,		
he dwelling must not contain third level habitable attic roo	m.		j.	Ú	
loor, walls and ceiling/roof				-	
	/roof of the dwelling in accordance with the specifications listed in the	e table	~	~	
onstruction	Additional insulation required (R-Value)	Other specifications			
oor - concrete slab on ground, 218.7 square metres	nil				
oor - above habitable rooms or mezzanine, 81.19 square letres, concrete	nil				
oor - suspended floor above garage, concrete	nil				
xternal wall - cavity brick	0.50 (or 1.17 including construction)				
	3.40 (including construction)				
xternal wall - other/undecided	3.40 (including construction)				

Energy Commitments	Show on DA plans	Show on CC/CDC plans & specs	Certifie check
Hot water			
The applicant must install the following hot water system in the development, or a system with a higher energy rating: electric heat pump with a performance of more than 45 STCs.	~	~	~
Cooling system			
The applicant must install the following cooling system, or a system with a higher energy rating, in at least 1 living area: 1-phase airconditioning; Energy rating: 6 Star (old label)		~	~
The applicant must install the following cooling system, or a system with a higher energy rating, in at least 1 bedroom: 1-phase airconditioning; Energy rating: 6 Star (old label)		 	~
Heating system			
The applicant must install the following heating system, or a system with a higher energy rating, in at least 1 living area: 1-phase airconditioning; Energy rating: 6 Star (old label)		~	~
The applicant must install the following heating system, or a system with a higher energy rating, in at least 1 bedroom: 1-phase airconditioning; Energy rating: 6 Star (old label)		 	~
Ventilation			
The applicant must install the following exhaust systems in the development:			
At least 1 Bathroom: individual fan, ducted to façade or roof; Operation control: manual switch on/off			
Kitchen: individual fan, not ducted; Operation control: manual switch on/off			•
		 Image: A set of the set of the	~
Laundry: individual fan, ducted to façade or roof; Operation control: manual switch on/off		~	~
Artificial lighting			
The applicant must ensure that the "primary type of artificial lighting" is fluorescent or light emitting diode (LED) lighting in each of the following rooms, and where the word "dedicated" appears, the fittings for those lights must only be capable of accepting fluorescent or light emitting diode (LED) lamps:			
 at least 6 of the bedrooms / study; dedicated 			
 at least 2 of the living / dining rooms; dedicated 			•
		 ✓ 	 ✓
the kitchen; dedicated			

 all bathroor
 the laundry
 all hallways
Natural ligh
The applicant
The applicant
Swimming
The developm
The applicant
Alternative
The applicant development.
Other
The applicant
The applicant definitions.
The applicant
The applicant

Description of project

e commitments set out below regulate how the proposed development is to be carried out. It is a condition of any develop velopment certificate issued, for the proposed development, that BASIX commitments be complied with.	1	,	
Water Commitments	Show on DA plans	Show on CC/CDC plans & specs	Certifier check
Fixtures			
The applicant must install showerheads with a minimum rating of 4 star (> 4.5 but <= 6 L/min plus spray force and/or coverage tests) in all showers in the development.		~	~
The applicant must install a toilet flushing system with a minimum rating of 6 star in each toilet in the development.		~	~
The applicant must install taps with a minimum rating of 6 star in the kitchen in the development.		~	
The applicant must install basin taps with a minimum rating of 6 star in each bathroom in the development.		v	
Alternative water			
Rainwater tank			
The applicant must install a rainwater tank of at least 3000 litres on the site. This rainwater tank must meet, and be installed in accordance with, the requirements of all applicable regulatory authorities.	~	~	~
The applicant must configure the rainwater tank to collect rain runoff from at least 375.6 square metres of the roof area of the development (excluding the area of the roof which drains to any stormwater tank or private dam).		~	~
The applicant must connect the rainwater tank to:			
all toilets in the development		~	~
 at least one outdoor tap in the development (Note: NSW Health does not recommend that rainwater be used for human consumption in areas with potable water supply.) 		~	~
Swimming pool			
The swimming pool must not have a volume greater than 100 kilolitres.	~	 	
The swimming pool must have a pool cover.		~	
The swimming pool must be outdoors.			

	The	swimming	pool	must	be	outd
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BASIX	Planning, Industry & Environment	www.basix.nsw.gov.au	Version: 3.0 / DARWINIA

	ommitments			Show on DA plans	Show on CC/CDC plans & specs	Certifier check	
Windows, glazed do	ors and skylights	5					
			evices described in the table belo ons must be satisfied for each wir		~	~	~
The dwelling may have 1 s	skylight (<0.7 square m	~	~	~			
The following requirement	s must also be satisfied	~	~	~			
 For the following glass 	and frame types, the c	certifier check can b	e performed by visual inspection.				_
- Aluminium single c	lear						
- Aluminium double ((air) clear						
- Timber/uPVC/fibre	glass single clear						
- Timber/uPVC/fibre	glass double (air) clear						
Vertical external louvre	es and blinds must fully	shade the window	or glazed door beside which they	are aituated when fully drawn or			
closed.		shade the window	of glazed door beside which they	are situated when fully drawn of		 	 ✓
closed. Overshadowing building 		of the height and di	istance from the centre and the ba		•	, s	Ĵ
closed. Overshadowing buildin 	ngs/vegetation must be the 'overshadowing' co	of the height and di			sion within	Overshadowing	
closed. Overshadowing buildir door, as specified in t 	ngs/vegetation must be the 'overshadowing' co Maximum	of the height and di lumn. Maximum width	istance from the centre and the b	ase of the window and glazed Shading Device (Dimens	sion within	Overshadowing	`
closed. Overshadowing buildir door, as specified in the specified of the specified in the specified in the specified in the specified of the specified	ngs/vegetation must be the 'overshadowing' co Maximum	of the height and di lumn. Maximum width	istance from the centre and the b	ase of the window and glazed Shading Device (Dimens		Overshadowing >4 m high, <2 m away	
closed. • Overshadowing buildir door, as specified in the Window/glazed door no. North facing	ngs/vegetation must be the 'overshadowing' co Maximum height (mm)	of the height and di lumn. Maximum width (mm)	istance from the centre and the b	ase of the window and glazed Shading Device (Dimens 10%) eave 3000 mm, 100 mm a	above head		·
closed. • Overshadowing buildir door, as specified in f Window/glazed door no. North facing W1	ngs/vegetation must be the 'overshadowing' co Maximum height (mm) 6000	of the height and di lumn. Maximum width (mm) 435	Type aluminium, single, clear	ase of the window and glazed Shading Device (Dimensi 10%) eave 3000 mm, 100 mm a of window or glazed door eave 3000 mm, 100 mm a	above head	>4 m high, <2 m away	

Window/glazed door no.	Maximum height (mm)	Maximum width (mm)	Туре	Shading Device (Dimension within 10%)	Overshadowing
SD4	2400	3960	aluminium, single, clear	eave 1200 mm, 325 mm above head of window or glazed door	2-4 m high, 2-5 m away
W22	2400	1200	aluminium, single, clear	external louvre/vertical blind (fixed)	>4 m high, 5-8 m away
East facing					
W20	2100	1810	aluminium, single, clear	solid overhang 3000 mm, 600 mm above head of window or glazed door	2-4 m high, 2-5 m away
W21	2100	730	aluminium, single, clear	none	2-4 m high, 2-5 m away
W39	1800	1210	aluminium, single, clear	none	>4 m high, 2-5 m away
W40	1800	1210	aluminium, single, clear	none	2-4 m high, 2-5 m away
W41	1800	730	aluminium, single, clear	none	2-4 m high, 2-5 m away
W42	1800	730	aluminium, single, clear	none	2-4 m high, 2-5 m away
W43	1800	730	aluminium, single, clear	none	2-4 m high, 2-5 m away
South facing					
W37	2100	2250	aluminium, single, clear	none	>4 m high, <2 m away
W38	2100	2250	aluminium, single, clear	none	>4 m high, 2-5 m away
SD2	3000	4495	aluminium, single, clear	verandah 9900 mm, 2975 mm above base of window or glazed door	2-4 m high, 2-5 m away
SD3	3000	4495	aluminium, single, clear	verandah 9900 mm, 2975 mm above base of window or glazed door	2-4 m high, 2-5 m away
SD5	2400	3600	aluminium, single, clear	eave 830 mm, 340 mm above head of window or glazed door	2-4 m high, 2-5 m away
West facing					
W9	600	3000	aluminium, single, clear	none	>4 m high, 2-5 m away
W23	970	2650	aluminium, single, clear	none	>4 m high, <2 m away
W24	970	2650	aluminium, single, clear	none	>4 m high, <2 m away
W25	970	2650	aluminium, single, clear	none	>4 m high, 2-5 m away
W26	970	1210	aluminium, single, clear	none	>4 m high, 5-8 m away

Energy Commitments	Show on DA plans	Show on CC/CDC plans & specs	Certifier check
all bathrooms/toilets; dedicated		_	~
the laundry; dedicated			L L
all hallways; dedicated		Ĵ.	Ĵ
Natural lighting			
The applicant must install a window and/or skylight in the kitchen of the dwelling for natural lighting.	~	~	~
The applicant must install a window and/or skylight in 4 bathroom(s)/toilet(s) in the development for natural lighting.	~	 Image: A set of the set of the	~
Swimming pool			
The development must not incorporate any heating system for the swimming pool.		~	
The applicant must install a timer for the swimming pool pump in the development.		 Image: A set of the set of the	
Alternative energy			
The applicant must install a photovoltaic system with the capacity to generate at least 0.6 peak kilowatts of electricity as part of the development. The applicant must connect this system to the development's electrical system.	~	 Image: A set of the set of the	~
Other			
The applicant must install a gas cooktop & electric oven in the kitchen of the dwelling.		~	
The applicant must construct each refrigerator space in the development so that it is "well ventilated", as defined in the BASIX definitions.		 Image: A set of the set of the	
The applicant must install a fixed outdoor clothes drying line as part of the development.		~	
The applicant must install a fixed indoor or sheltered clothes drying line as part of the development.			

Legend	
In these commitments, "applicant" means the person carrying out the developm	ent.
Commitments identified with a v in the "Show on DA plans" column must be sidevelopment application is to be lodged for the proposed development).	hown on the j
Commitments identified with a v in the "Show on CC/CDC plans and specs" concertificate / complying development certificate for the proposed development.	olumn must b
Commitments identified with a v in the "Certifier check" column must be certififiant) for the development may be issued.	ed by a certif

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REV	DATE	DESCRIPTION	E	вү	Design.	STRUCTURAL ENGINEERING & ARCHITECTURAL DESIGN	

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plans accompanying the development application for the proposed development (if a
be shown in the plans and specifications accompanying the application for a construction
ifying authority as having been fulfilled, before a final occupation certificate(either interim or

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	PROPOSED TWO STOREY DWELLING WITH	JOB NUMBER:	DWG NUMBER:	ORIGINAL SIZE:
SS: LEVEL 1, CHAPEL RD, BANKSTOWN,	BASEMENT & POOL	22808	A16	A3
00 5556 M: 0422 606 228 am@nemcodesign.com.au	50 CHASELING ST, GREENACRE LOT 75, DP 35156	DESIGNED BY: A.N.	DATE: 03.02.2023	\square
- •		7.IN.	03.02.2023	
	BASIX REQUIREMENTS	DRAWN BY:	SCALE:	
		A.N.	AS SHOWN	$\nabla \mathcal{V}$